
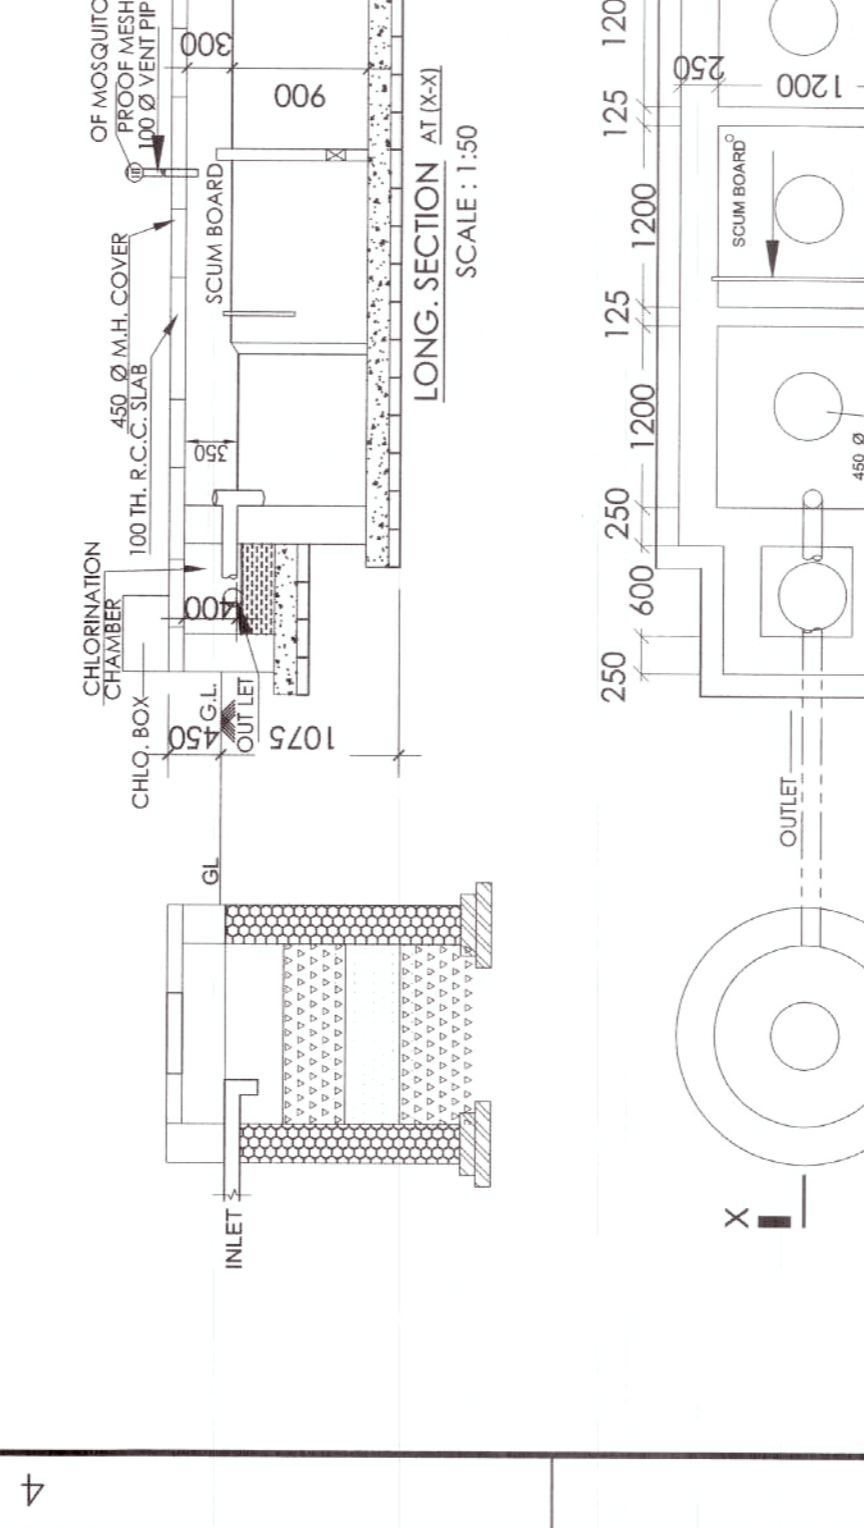


DOOR SCHEDULE			WINDOW SCHEDULE		
MKD	WIDTH	HEIGHT	MKD	WIDTH	HEIGHT
D	1800	2100	WT	1500	850
D	1200	2100	WS	1200	850
D	900	2100	WS	900	850
D	800	2100	WS	600	850
D	750	2100	WS	600	1100
D	2400	2100	WS	600	1550
D	2400	2100	WS	600	800

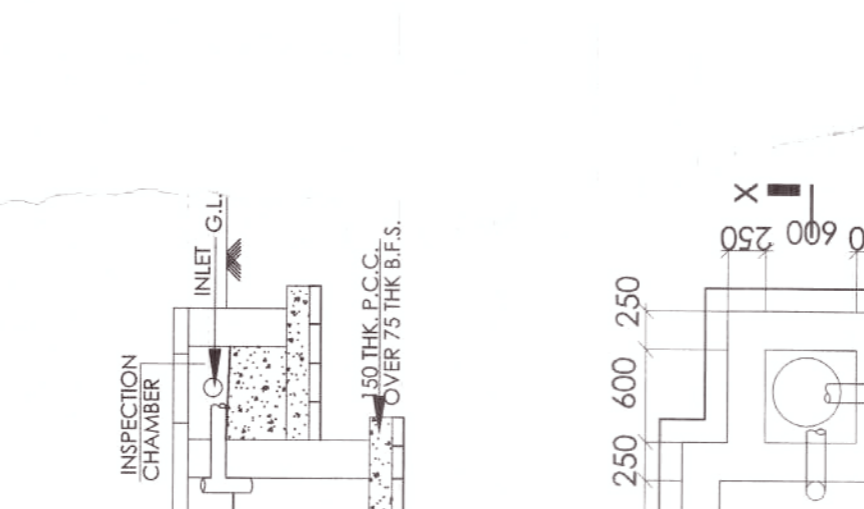

RECOMMENDED
NOTES
 1. Future vertical and horizontal extension will be the owner's responsibility.
 2. Underpinning and foundation work shall be carried out as per the Structural Engineer's report submitted by the client.
 3. Foundation has been designed for the proposed construction. The contractor shall refer to the Structural Engineer's report for any future support during construction.
 4. Considering the client's request, the contractor shall refer to the Structural Engineer's report for any future support during construction.
 5. The drawing shall be used for the purpose issued and shall not be used for any other purpose without written consent from the architect.

Received
 Dr. Parth Choudhary
 B.E. (Civil), M.E. (Structural Engg.), Ph.D. (Engg.)
 Professor
 Construction Engg. Department
 Jadavpur University, Kolkata-700 036

RESIDENTIAL SANCTIONED
 28/12/21
 Assistant Executive Officer
 Urban Engineering, Panchajanya

NOTES
 1. ALL DIMENSIONS & LEVELS ARE IN MM, UNLESS MENTIONED OTHERWISE.
 2. ALL EXTERNAL WALLS ARE 200 MM THICK & INTERNAL WALLS 100 MM / 200 MM THICK, UNLESS MENTIONED OTHERWISE.
 3. THE DRAWING SHALL BE READ, NOT SCALED EITHER IN PART OR IN FULL.
 4. THE DRAWING SHALL BE USED FOR THE PURPOSE ISSUED AND SHALL NOT BE USED FOR ANY OTHER PURPOSE WITHOUT WRITTEN CONSENT FROM THE ARCHITECT.

SOVA REAL ESTATE LLP
 Partner
 SOVA REAL ESTATE LLP
 Partner

SIGNATURE OF OWNERS
CERTIFICATE OF STRUCTURAL ENGINEER :
 THIS IS TO CERTIFY THAT THE STRUCTURAL DESIGN AND DRAWING OF BOTH FOUNDATION AND SUPER-STRUCTURE OF THE BUILDING HAS BEEN MADE BY ME CONSIDERING ALL POSSIBLE LOADS INCLUDING THE SEISMIC LOAD AS PER THE NATIONAL BUILDING CODE OF INDIA AND CERTIFIED THAT IT IS SAFE AND STABLE IN ALL RESPECTS.

Satyajit Mondal
 SATYAJIT MONDAL
 S.C.E. (M.E.)
 Chartered Engineer (INDIA)
 (AM 1907895)
 KMC Empowered Structural Engineer
 Class-II, (ESE/II/1627)

SIGNATURE OF ARCHITECT
CERTIFICATE OF ARCHITECT :
 I DO HEREBY CERTIFY WITH FULL RESPONSIBILITY THAT THE BUILDING PLAN HAS BEEN DRAWN UP AS PER WEST BENGAL MUNICIPAL BUILDING RULES 2007 AS AMENDED FROM TIME TO TIME. THAT THE WIDTH OF THE ABUTTING ROAD CONFORM WITH THE PLAN AND IT IS A BUILDABLE SITE, NOT A TANK OR A FILLED UP TANK. THE SITE PLAN, LOCATION PLAN AGREES WITH THE SITE. THE PLOT IS DEMARCATED BY BOUNDARY WALLS & MEASUREMENTS TALLY WITH THE REGD. DEED PLAN. THE CONSTRUCTION OF U.G.W.R. & S.T.P. WILL BE COMPLETED UNDER GUIDANCE OF ARCHITECT & E.S.E. THE LAND IS VACANT.

Pankaj Banik
 PANKAJ BANIK
 ARCHITECT
 CAZP/2012/25
 (M)1907810/11

SOVA REAL ESTATE LLP
 Partner
 Project : AVANTI VILLATOWER-2 OF SOVA REAL ESTATE LLP
 PROPOSED B+G+10 STORIED RESIDENTIAL BUILDING OF AT MOUZE-PAIKPARI, J.L. NO.-286, PLOT NOS.-1810,1811 & 1812 TOTAL ADJACENT LAND 42.5 DECIMAL UNDER KOLA-2 GRAM PANCHAYAT, P.S.-KOLAGHAT, BLOCK-PANSKURA-II, PURBA MEDINIPUR.

Consultant : PERFECT CONSULTANCY SERVICES
 1, ANANDA CHATTERJEE LANE, KOLKATA-700003.

Drawing Title : BASEMENT TO ROOF PLAN, SEPTIC TANK, DOOR & WINDOW SCHEDULE

Scale : AS SHOWN Date : 29.09.2020

Dealt : Checked Approved

Design Development Sanction Dwg
 Contract Document Construction Dwg As Built Dwg

Revision No. : Revision Date.

R0
 Drawing No. : A-02
 Job No. : 1917

North